

GROUND FLOOR LIVING 128.4 PORCH ALFRESCO 21.5 157.0 sq.m. UPPER FLOOR LIVING 129.5 BALCONY 12.9 TOTAL 142.4 sq.m TOTAL BUILD 299,4 sq.m. 336 sq.m. AREA OF SITE SITE COVER

NOTE

STORMWATER TO DISCHARGE INTO EXIST. STORMWATER LINES & RETICULATE TO EXIST. LAWFULL POINT OF DISCHARGE

ALL STORMWATER LINES TO HAVE MINIMUM 100mm COVER.

STORMWATER LINES SHOWN ARE INDICATIVE ONLY

THE CONTRACTOR IS RESPONSIBLE TO ENSURE COMPLIENCE WITH AS.3500, AS.2870 AND BCA

NOTE

DRAWING SYMBOLS USED ON THIS DRAWING ARE NOT TRUE REPRESENTATION OF ITEMS INCLUDED IN CONTRACT.
REFER TO CONTRACT FOR SPECIFIED ITEMS

REAL PROPERTY DESCRIPTION

LOT 26 ON SP228841

PARISH: REDCLIFFE COUNTY: STANLEY

AREA : 336 sq.m.

SITE PLAN

SCALE 1: 200

MANCORP QUALITY HOMES


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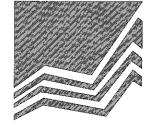
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* WINDOW CODES DENOTE HEIGHT x WIDTH e.g. 1218 - 1200 HIGH x 1800 WIDE,

AMEN	DMENTS		CLIENT		
ISSUE	DATE	DESCRIPTION	MANCORP QUALITY HOMES	DRAWN: A.WATTS	CHECKED: 27/4/10
A	23/04/10	WORKING DRAWING	PROJECT PROPOSED RESIDENCE	DATE: 23/04/10	SCALE: AS SHOWN
			LOT 26 AUGUSTA PARADE, NORTH LAKES	JOB NO.	SHEET No. 1 OF 11







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ISSUE	DATE	DESCRIPTION	MANCORP QUALITY HOMES		DRAWN: A.WATTS	CHECKED: 27/4/10
A	23/04/10	WORKING DRAWING	PROJECT PROPOSED RESIDENCE	-	DATE: 23/04/10	SCALE: AS SHOWN
	ļ		LOCATION		JOB NO.	SHEET No.
			LOT 26 AUGUSTA PARADE, NORTH LAKES			2 OF 11

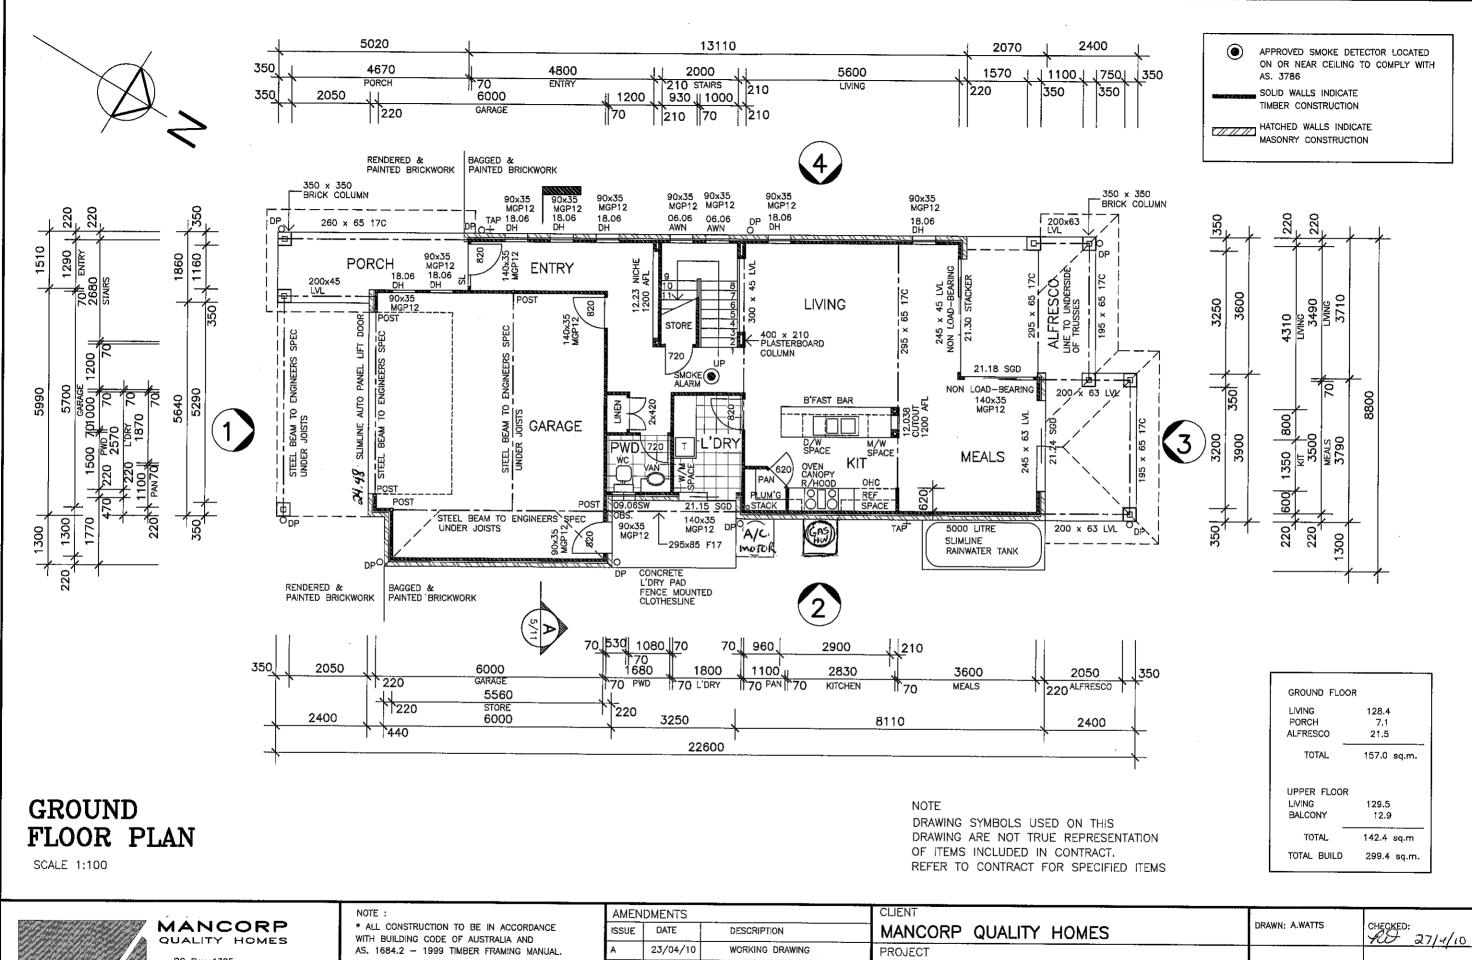



QUALITY HOMES
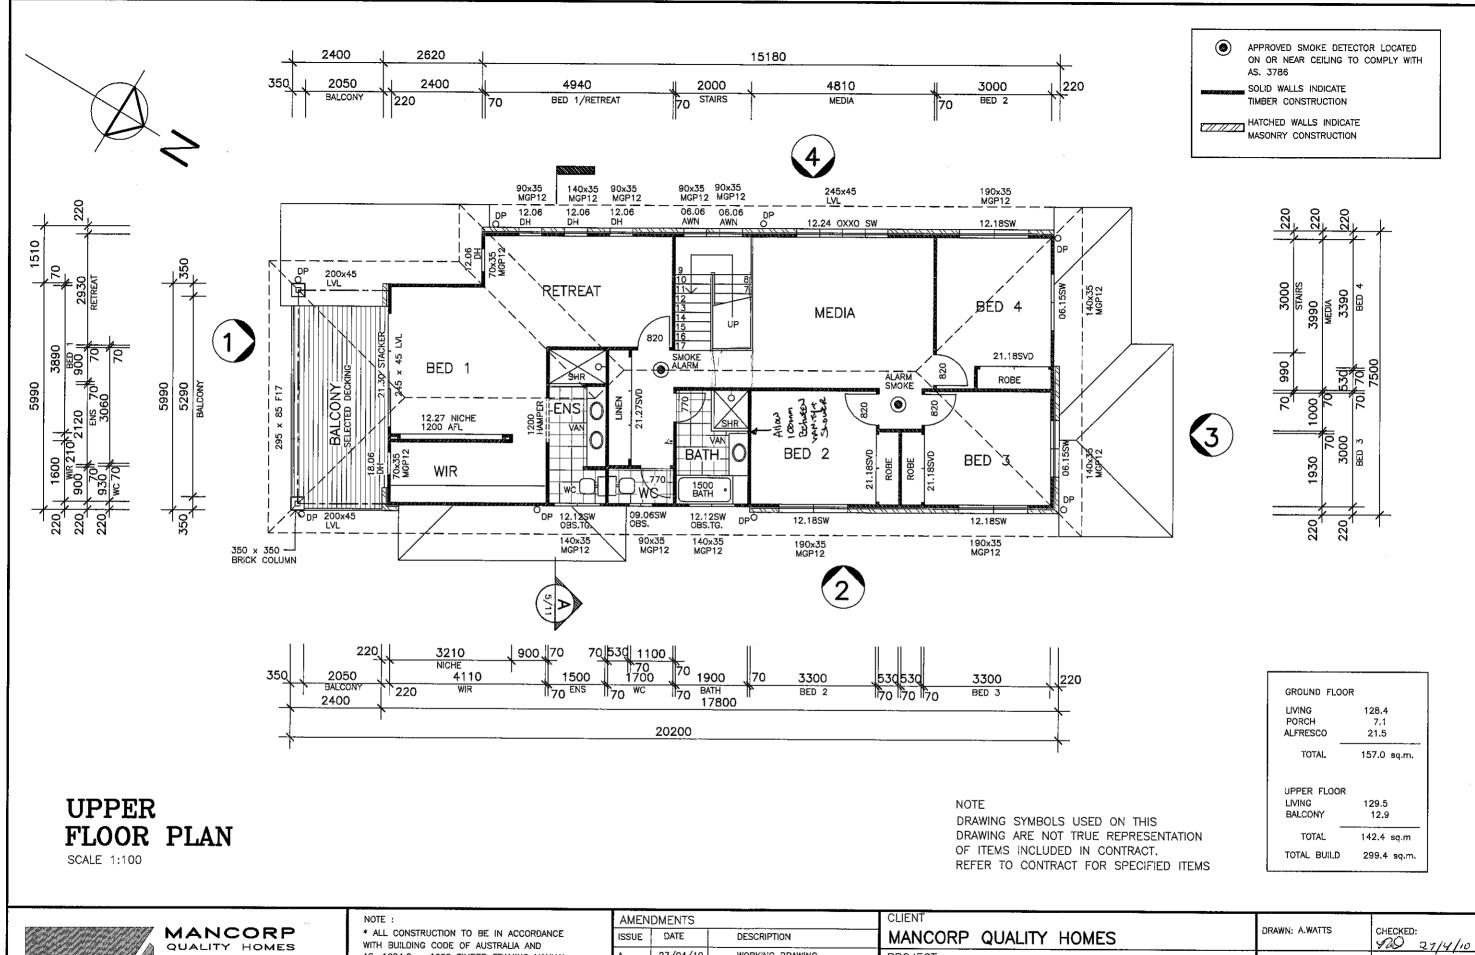
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ISSUE	DATE	DESCRIPTION	MANCORP QUALITY HOMES
Α	23/04/10	WORKING DRAWING	PROJECT
			PROPOSED RESIDENCE
			LOCATION
			LOT 26
			AUGUSTA PARADE, NORTH LAKES

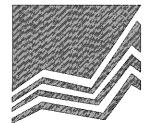
DATE: 23/04/10

JOB NO.


SCALE; AS SHOWN

3 OF 11


SHEET No.

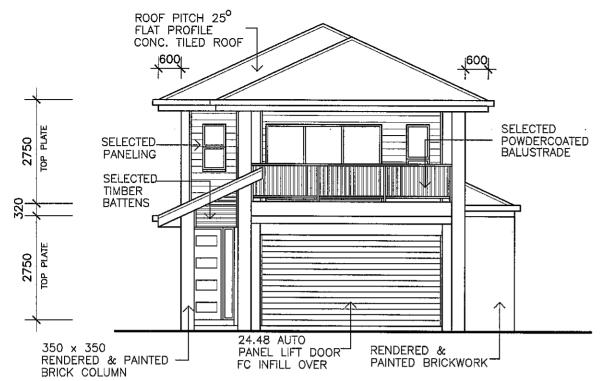

ELEVATION 1

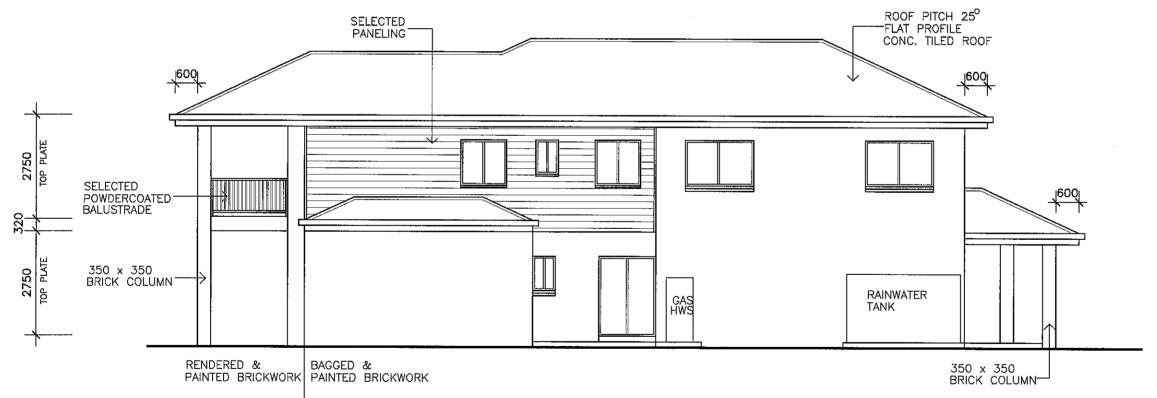

ELEVATION 2

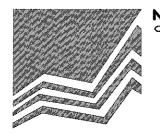

MANCORP QUALITY HOMES

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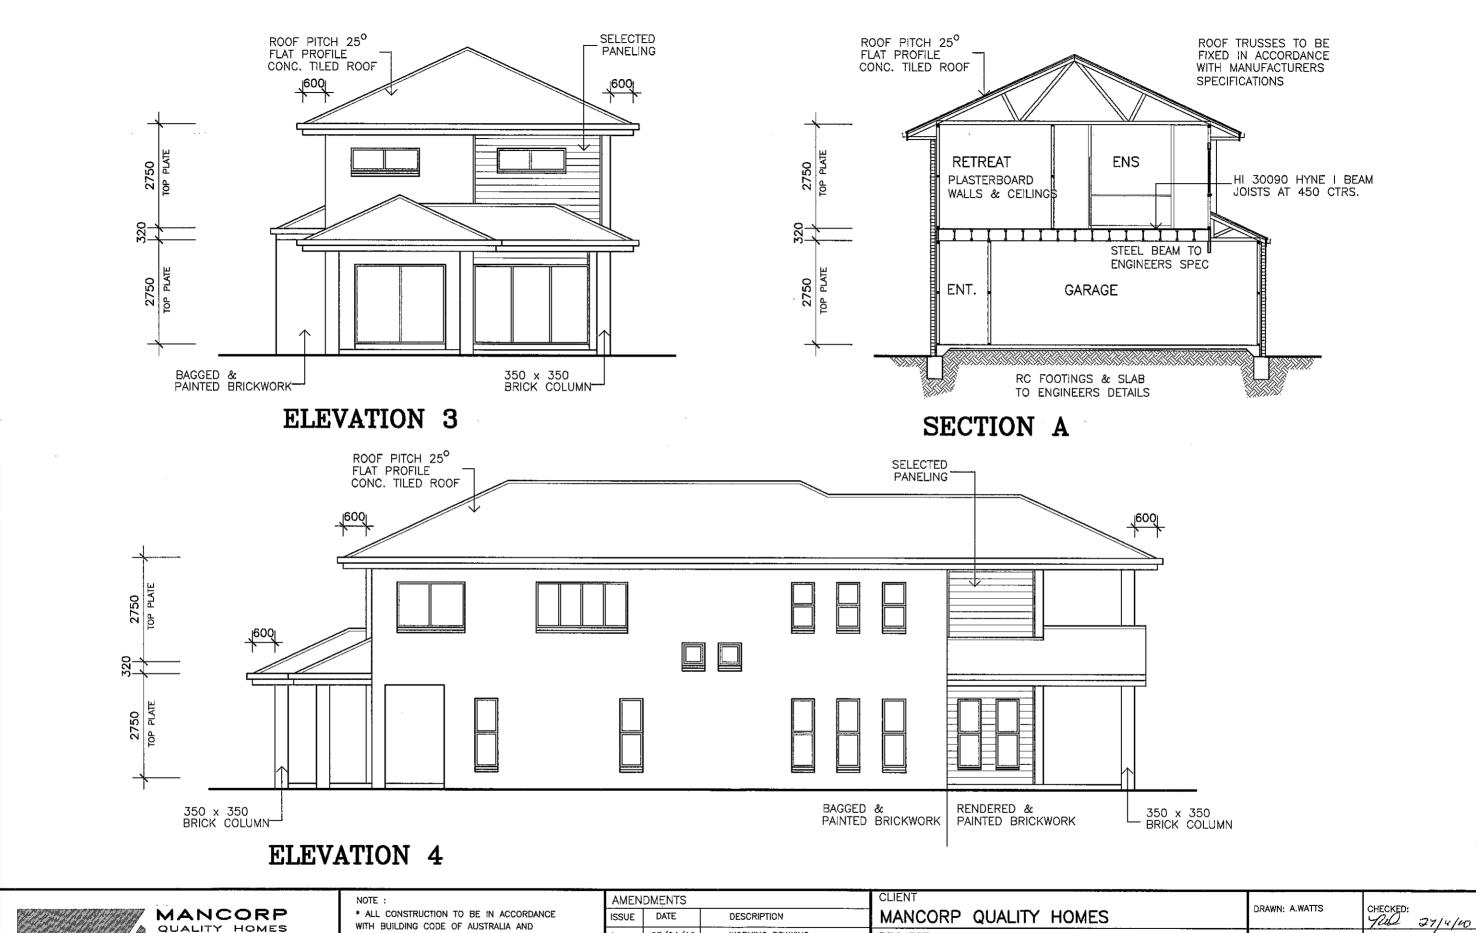
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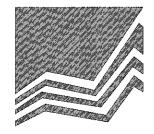
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AMEN	AMENDMENTS		CLIENT	DRAWAY A MILETO	
ISSUE	DATE	DESCRIPTION	MANCORP QUALITY HOMES	DRAWN: A.WATTS	CHECKED:
Α	23/04/10	WORKING DRAWING	PROPOSED RESIDENCE	DATE: 23/04/10	SCALE: AS SHOWN
			LOCATION LOT 26 AUGUSTA PARADE, NORTH LAKES	JOB NO.	SHEET NO. 4 OF 11





MANCORP

QUALITY HOMES

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ISSUE	DATE	DESCRIPTION	MANCORP QUALITY HOMES		
A	23/04/10	WORKING DRAWING	PROPOSED RESIDENCE		
			LOCATION		
			LOT 26 AUGUSTA PARADE, NORTH LAKES		


DATE: 23/04/10

JOB NO.

SCALE: AS SHOWN

5 OF 11

SHEET No.

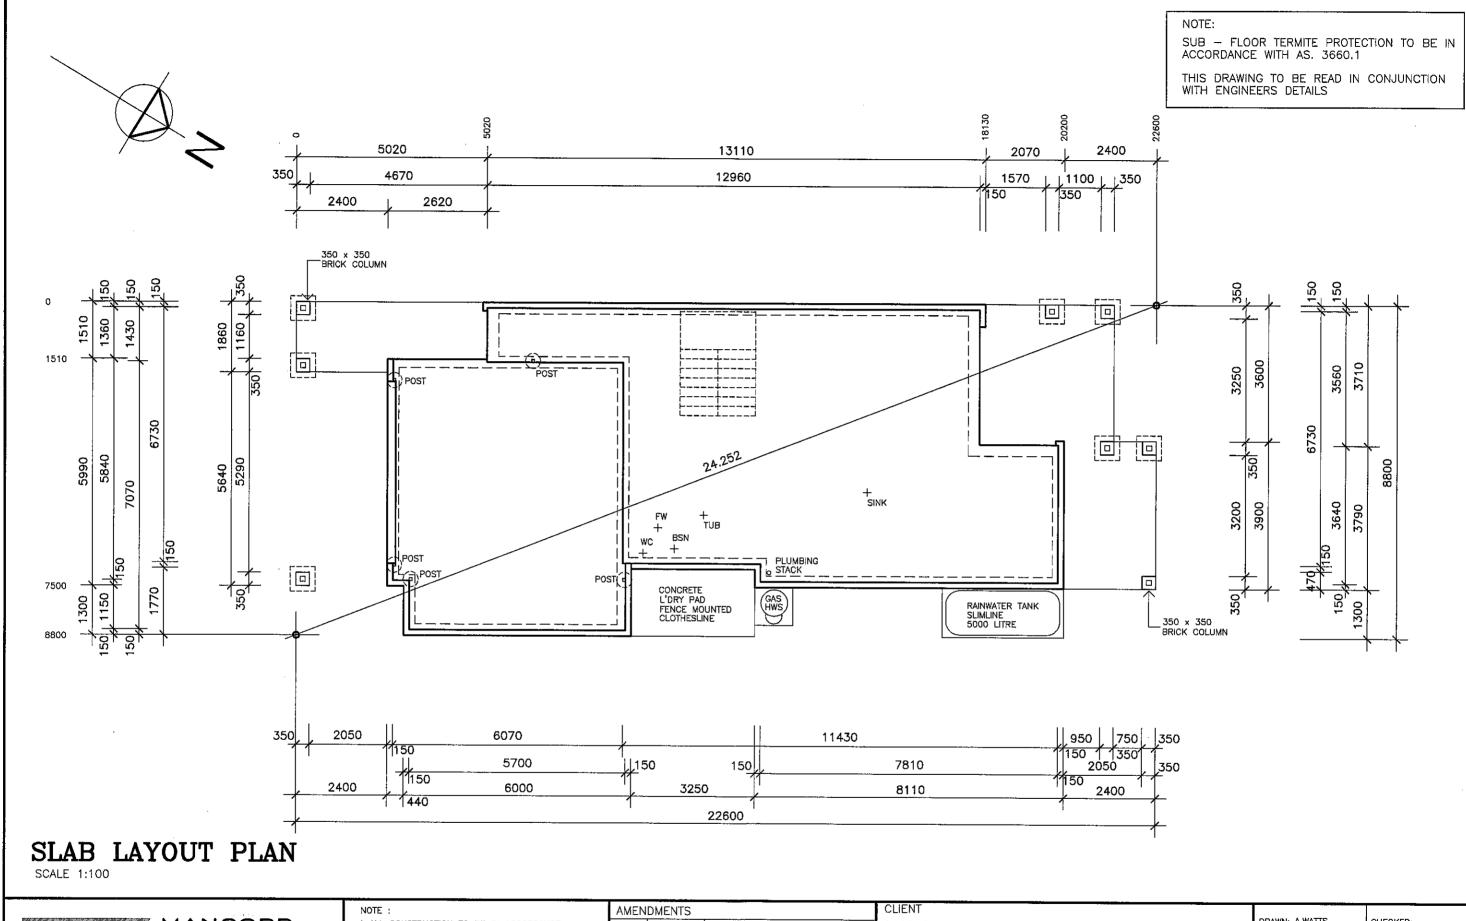



MANCORP QUALITY HOMES


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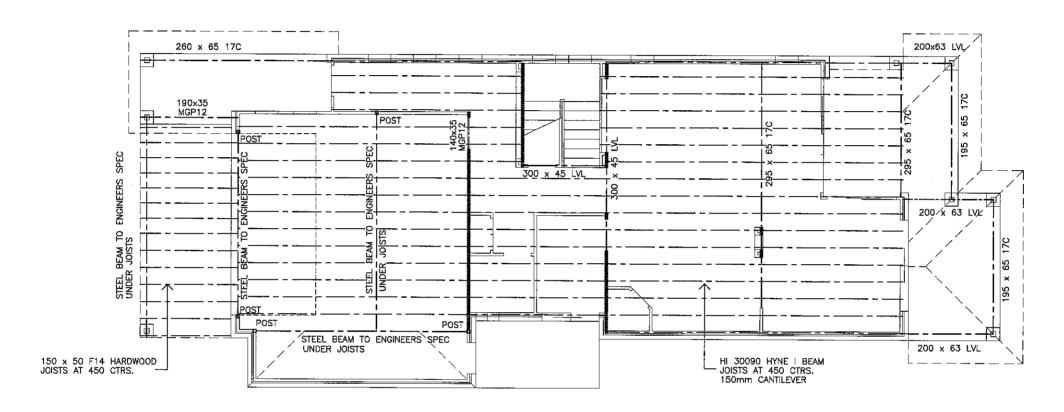
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ISSUE	DATE	DESCRIPTION	MANCORP QUALITY HOMES	DRAWN: A.WATTS	CHECKED:
A	23/04/10	WORKING DRAWING	PROJECT PROPOSED RESIDENCE	DATE: 23/04/10	SCALE: AS SHOWN
			LOT 26 AUGUSTA PARADE, NORTH LAKES	JOB NO.	SHEET No. 6 OF 11






JOIST LAYOUT PLAN

SCALE 1: 100

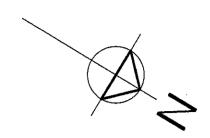NOTE: LOAD BEARING WALLS SHOWN ARE HATCHED BEAMS SHOWN TO BE CONCEALED WITHIN FLOOR BUTT JOINTED TO BEAMS (UNLESS SPECIFIED)

SCALL 1. 100

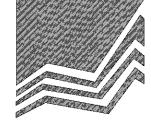

MANCORP QUALITY HOMES

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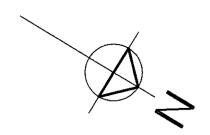
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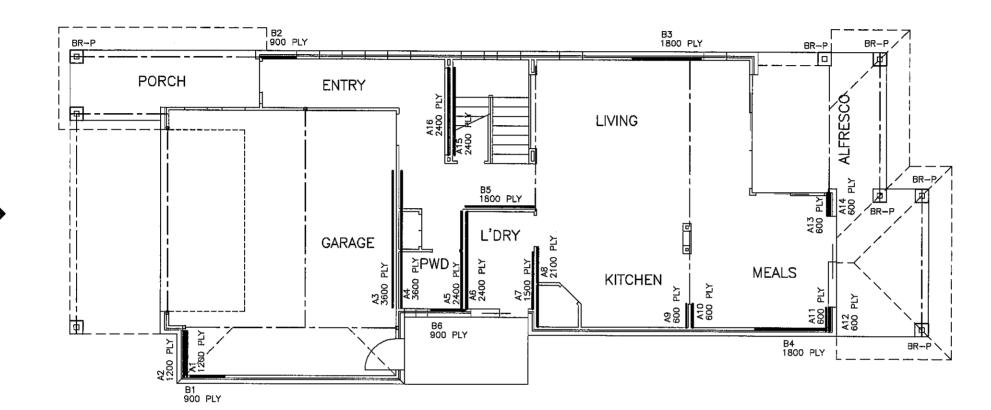
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ISSUE	DATE	DESCRIPTION	MANCORP QUALITY HOMES	DRAWN; A.WATTS	CHECKED: 27/4/10
A	23/04/10	WORKING DRAWING	PROJECT PROPOSED RESIDENCE	DATE: 23/04/10	SCALE: AS SHOWN
			LOCATION LOT 26 AUGUSTA PARADE, NORTH LAKES	JOB NO.	SHEET No. 7 OF 11




DIRECTION

59.3 kN.

NOTE:
PLYWOOD BRACING PANEL LESS THAN 900mm IN WIDTH
TO HAVE ADDITIONAL FIXINGS OF 1/M10 COACH SCREW
AT EACH CORNER OF THE PANEL OR 1/M12 ROD AT
EACH END OF PANEL



RESI	STANCE II	N HORIZONI	TAL DIRECTION			
CODE	TYPE	LENGTH	VALUE	TOTAL		
A1	PLY	1200	6.0kN/m	7.2		
A1	PLY	1200	6.0kN/m	7.2		
A3	PLY	3600	6.0kN/m	21.6		
A4	PLY	3600	6.0kN/m	21.6		
A5	PLY	2400	6.0kN/m	14,4		
A6	PLY	2400	6.0kN/m	14.4		
A7	PLY	1500	6.0kN/m	9.0		
A8	PLY	2100	6.0kN/m	12.6		
A9	PLY	600	6.0kN/m	3.6		
A10	PLY	600	6.0kN/m	3.6		
A11	PLY	600	6.0kN/m	3.6		
A12	PLY	600	6.0kN/m	3.6		
A13	PLY	600	6.0kN/m	3.6		
A14	PLY	600	6.0kN/m	3.6		
A15	PLY	2400	6,0kN/m	14.4		
A16	PLY	2400	6.0kN/m	14.4		
	BR-P 6 No. 2.2kN/m					
RESI	STANCE F	PROVIDED		171.6kN		
RESI	RESISTANCE REQUIRED 1					

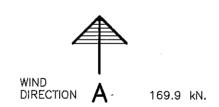

BRACING LEGEND

BR-P 350 x 350 BRICK PIER WITH M12 ROD 2.2kN/M

MAB GALVANISED METAL ANGLE DIAGONAL 1.5kN/M

.....<u>-</u>

STRUCTURAL PLYWOOD 4mm F14 WITH
ANCHOR BOLTS AND NAILING AT
50mm CTRS TOP & BOTTOM PLATES
300mm CTRS TO INTERMEDIATE STUDS

STRUCTURAL PLYWOOD 4mm F14 WITH
ANCHOR BOLTS AND NAILING AT
50mm CTRS TO INTERMEDIATE STUDS

BRAC	BRACING DIRESTION B					
RESI	STANCE I	N HORIZON	FAL DIRECTION			
CODE	TYPE	LENGTH	VALUE	TOTAL		
B1	PLY	900	6.0kN/m	5.4		
B2	PLY	900	6.0kN/m	5.4		
В3	PLY	1800	6.0kN/m	10.8		
84	PLY	1800	6.0kN/m	10.8		
85	PLY	1800	6,0kN/m	10.8		
B6	PLY	900	6.0kN/m	5.4		
	BR-P 6 No. 2.2kN/m					
RESI	RESISTANCE PROVIDED					
RESI	RESISTANCE REQUIRED					

GROUND FLOOR BRACING DETAIL (N3)

SCALE 1: 100




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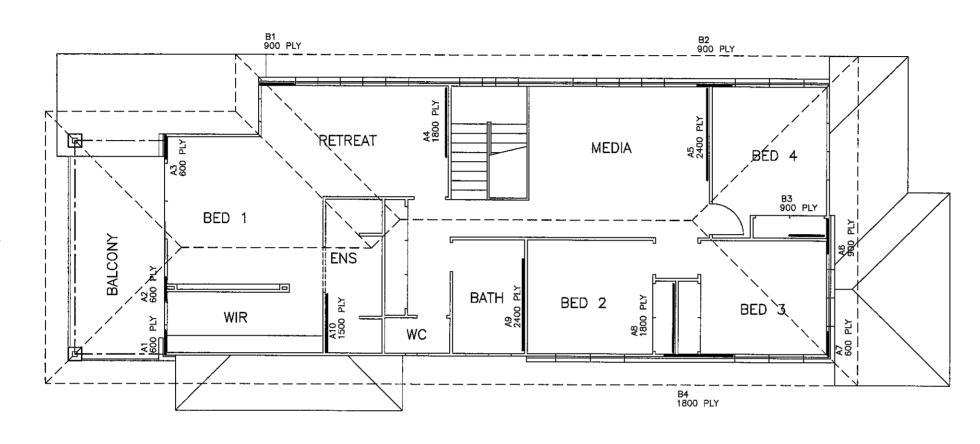
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AMENDMENTS		CLIENT	l	
DATE	DESCRIPTION	MANCORP QUALITY HOMES	DRAWN: A.WATTS	CHECKED: 760 27/4/10
23/04/10	WORKING DRAWING	PROPOSED RESIDENCE	DATE: 23/04/10	SCALE: AS SHOWN
		LOCATION LOT 26 AUGUSTA PARADE, NORTH LAKES	JOB NO.	SHEET No. 8 OF 11
	DATE	DATE DESCRIPTION	DATE DESCRIPTION MANCORP QUALITY HOMES 3/04/10 WORKING DRAWING PROJECT PROPOSED RESIDENCE LOCATION LOT 26	DATE DESCRIPTION MANCORP QUALITY HOMES 3/04/10 WORKING DRAWING PROJECT PROPOSED RESIDENCE LOCATION LOT 26 DRAWN: A.WATTS DATE: 23/04/10 DATE: 23/04/10



NOTE:
PLYWOOD BRACING PANEL LESS THAN 900mm IN WIDTH
TO HAVE ADDITIONAL FIXINGS OF 1/M10 COACH SCREW
AT EACH CORNER OF THE PANEL OR 1/M12 ROD AT
EACH END OF PANEL



BRAC	BRACING DIRESTION A						
RESI	RESISTANCE IN HORIZONTAL DIRECTION						
CODE	CODE TYPE LENGTH VALUE						
A1	PLY	600	6.0kN/m	3.6			
A2	PLY	600	6.0kN/m	3.6			
A3	PLY	600	6.0kN/m	3.6			
A4	PLY	1800	6.0kN/m	10.8			
A5	PLY	2400	6.0kN/m	14.4			
A6	PLY	900	6.0kN/m	5.4			
A7	PLY	600	6.0kN/m	3.6			
A8	PLY	1800	6.0kN/m	10.8			
A9	PLY	2400	6.0kN/m	14.4			
A10	PLY	1500	6.0kN/m	9.0			
RESI	RESISTANCE PROVIDED						
RESI	RESISTANCE REQUIRED						

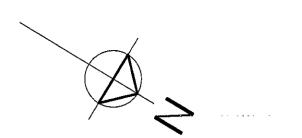É			
WIND DIRECTION	Å	74.8	k

BRACING LEGEND

BR-P 350 x 350 BRICK PIER WITH M12 ROD 2.2kN/M

MAB GALVANISED METAL ANGLE DIAGONAL BRACE

1.5kN/M

PLY

STRUCTURAL PLYWOOD 4mm F14 WITH ANCHOR BOLTS AND NAILING AT 50mm CTRS TOP & BOTTOM PLATES 300mm CTRS TO INTERMEDIATE STUDS

6.0kN/M

BRACING DIRESTION B						
RESISTANCE IN HORIZONTAL DIRECTION						
CODE	TOTAL					
В1	PLY	900	6.0kN/m	5.4		
B2	PLY	900	6.0kN/m	5.4		
вз	PLY	900	6.0kN/m	5.4		
B4	PLY	1800	6.0kN/m	10.8		
RESI	27.0kN					
RESISTANCE REQUIRED				26.6kN		

UPPER FLOOR BRACING DETAIL (N3)

SCALE 1: 100

DIRECTION

26.6 kN.



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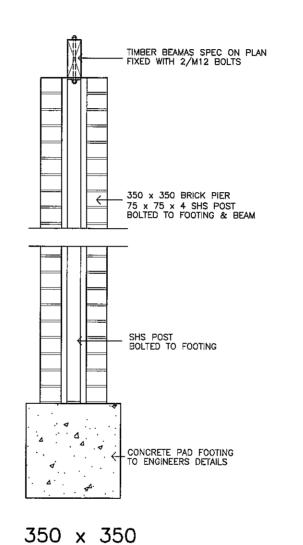
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<u> </u>			LOCATION	JOB NO.	SHEET No.
			LOT 26 AUGUSTA PARADE, NORTH LAKES		9 OF 11

TIEDOWN SHEDULE - N3 AREA					
TIMBER JOINT GROUP: JD4 WIND CLASSIFICATION: N3	ROOF MATERIAL & WEIGHT: CONC TILE 72kg/sqm ROOF LOAD WIDTH: 4.400m	ROOF PITCH: 25° WALL FRAMING HEIGHT: 2750			
CONNECTION	DESCRIPTION	SPACING			
TOP PLATE TO TRUSS OR RAFTER	ROOF TRUSSES TO BE FIXED TO TOP PLATES IN ACCORDANCE WITH MANUFACTURERS SPECIFICATIONS & SUPPLY	PER CONNECTION			
TOP AND BOTTOM PLATE TO STUD	M12 RODS x 1200 CTRS	1200 CENTRES			
NOGGING TO STUDS	2/75mm 3.05mm NAIL SKEWED OR THROUGH NAILED	MAX 1350 CTRS			
BOTTOM PLATE TO SŁAB	M12 RODS x 1200 CTRS	1200 CENTRES			
NOTE: PROVIDE M12 RODS EITHER SIDE OF BRACING PANELS LESS THAN 900mm WIDE PROVIDE M12 RODS EITHER SIDE OF OPENINGS 3000mm OR GREATER.					

	TIMBER FRAMING SCHEDULE				
TIMBER JOINT GROUP: JD4 WIMD CLASIFICATION: N3	ROOF MATERIAL: COT ROOF LOAD WIDTH:		ROOF PITCH: 25° WALL FRAMING HEIGHT: 2.7m		
MEMBER	POSITION	SIZE	GRADE	SPACING	
LOAD-BEARING					
GROUND FLOOR 70mm					
TOP PLATES	EXTERNAL/INTERNAL STUD WALL	2/70 x 35	MGP12	M12 ROD 1200 CTRS	
STUD (NOT NOTCHED)	35 16 25	70 x 35	MGP12	450 CTRS	
BOTTOM PLATES	24 le 29	70 x 35	MGP10	M12 ROD 1200 CTRS	
NOGGING	21 } 29	70 x 35	MGP10	1350 CTRS	
LOAD-BEARING					
UPPER FLOOR 70mm					
TOP PLATES	EXTERNAL STUD WALL	2/70 x 35	MGP12	M12 ROD 1200 CTRS	
STUD (NOT NOTCHED)	13 31 19	70 x 35	MGP12	450 CTRS	
BOTTOM PLATES	10 H 29	2/70 x 35	MGP12	M12 ROD 1200 CTRS	
NOGGING	10 10 39	70 x 35	MGP10	1350 CTRS	
NON LOAD-BEARING					
TOP PLATES	INTERNAL STUD WALL	70 x 35	MGP10	NOMINAL FIXING	
STUD (NOT NOTCHED)	38 39 29	70 x 35	MGP10	450 CTRS	
BOTTOM PLATES	11 19 19	70 x 35	MGP10	NOMINAL FIXING	
NOGGING	33 31 13	70 x 35	MGP10	1350 CTRS	
STUDS SIDES OF OPENINGS	OPENING TO 1300	2/STUD	MGP12		
38 78 23	" 1300 TO 2200	3/STUD	MGP12		
19 93 93	" 2200 TO 3200	4/STUD	MGP12		
38 39 [3	" 3200 TO 4400	4/STUD	MGP12		

BRICK LINTELS


OPENING WIDTH (mm)	BRICKWALL UP TO 1500mm HEIGHT	BRICKWALL UP TO 1500mm HEIGHT
900	75 x 100 x 6	75 x 100 x 6
1200	75 x 100 x 6	75 x 100 x 6
1500	75 x 100 x 6	100 x 100 x 6
1800	100 x 100 x 6	100 x 100 x 6
2100	100 x 100 x 6	100 x 100 x 6
2400	100 x 100 x 6	150 x 90 x 8



METHOD OF TIEDOWN (N3)

SCALE 1:20

BRICK PIER

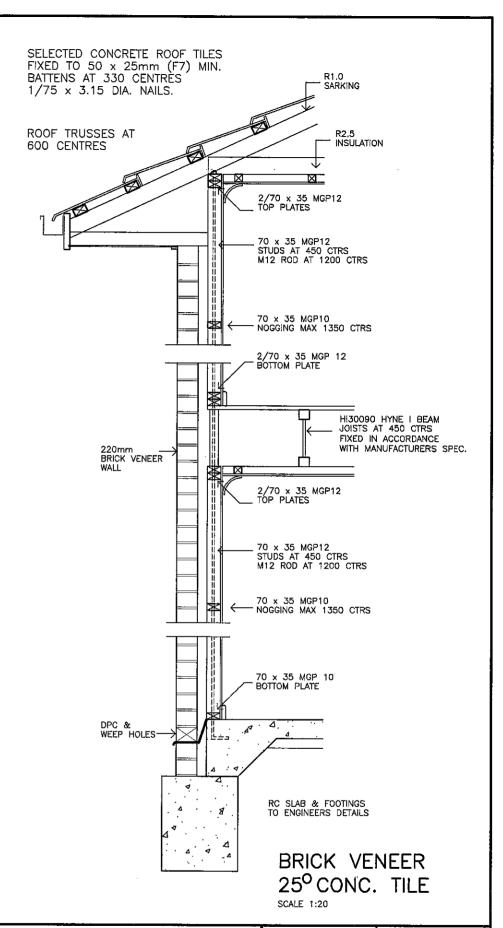




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AMENDMENTS			CLIENT	1	
ISSUE	DATE	DESCRIPTION	MANCORP QUALITY HOMES	DRAWN; A.WATTS	CHECKED: 27/4/10
A	23/04/10	WORKING DRAWING	PROJECT PROPOSED RESIDENCE	DATE: 23/04/10	SCALE: AS SHOWN
			LOCATION LOT 26 AUGUSTA PARADE, NORTH LAKES	JOB NO.	SHEET No. 10 OF 11
			<u> </u>		



GENERAL NOTES

ALL CONSTRUCTION SHALL CONFORM STRICTLY WITH THE REQUIREMENTS OF THE BUILDING CODE OF AUSTRALIA, THE QUEENSLAND BUILDING ACT 1975—1990 TOGETHER WITH THE BUILDING AMENDMENTS ACT 1991, THE QUEENSLAND HOME BUILDING CODE AND THE AUSTRALIAN DOMESTIC CONSTRUCTION MANUAL — QUEENSLAND EDITION INCLUSIVE OF ANY AMENDMENTS & ATTACHMENTS PUBLISHED AFTER THE RELEVANT DATES OF PROCLAMATION OR RELEASE AS MAY BE THE CASE.

ALL MATERIALS USED FOR THE CONSTRUCTION WORK COVERED BY THESE PLANS SHALL BE NEW AND TOP QUALITY.

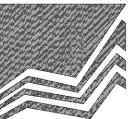ALL TIMBER CONSTRUCTION SHALL BE IN ACCORDANCE WITH AS.1684.2-2006 RESIDENTIAL TIMBER FRAMED CONSTRUCTION.

ALL DIMENSIONS AND LEVELS MUST BE CHECKED BY BUILDER PRIOR TO THE COMMENCEMENT OF WORKS. ON OR OFF SITE.

ALL WET AREAS TO COMPLY WITH AS.3740-2004.

WC DOORS CPENING INWARDS TO BE FITTED WITH LIFT-OFF HINGES TO ALLOW THE DOOR TO BE REMOVED WHEN IN A CLOSED POSITION.

BRICKWORK

110mm BRICKWORK ATTACHED TO FRAME WITH APPROVED TIES SPACED HORIZONTALLY AND VERTICALLY TO AS.3700. FLASHING/DAMP COURSE TO BE PLACED BELOW FLOOR SLAB LEVEL TO PERIMETER OF BUILDING. WEEP HOLES TO BE PLACED EVERY 900mm CENTRES HORIZONTALLY AT DAMP COURSE LEVEL AND AT OTHER LEVELS WHERE THERE IS HORIZONTAL FLASHINGS.

ALL BRICKWORK, BRICK TIES AND MORTAR IS TO BE AS.3700.

ALL WINDOWS & DOORS IN BRICKWORK TO HAVE FLASHING & BRICK SILLS.

JOINERY

ALL JOINERY TO BE ALUMINIUM FRAMED WITH POWDERCOATING TO CONFORM TO AS.2047 & AS.1288.

NO LOAD IS TO BEAR ON FRAMES.

KEEP ALL FRAMES & GLAZING CLEAR OF CONCRETE, MORTAR & SOLVENTS.

ALL SLIDING GLASS DOORS SHALL BE WITHOUT MID-RAILS.

ALL HINGED DOORS (INCLUDING FRONT DOOR) TO BE AS NOMINATED ON CONTRACT.

LININGS

INTERNAL LININGS TO BE PLASTERBOARD, 10mm TO WALLS & 13mm OR 10mm ABLE TO SPAN 600mm TO CEILINGS.

10mm GAP TO BE LEFT BETWEEN FLOOR & SHEETING.

FIXING, CONTRACTION JOINT LOCATIONS & LEVEL OF FINISH IS TO BE AS PER AS/NZ.2589.1-1997 OR MANUFACTURERS SPECIFICATION.

CORNICE TYPE AS PER CONTRACT.

WET AREA LININGS TO BE VILLABOARD OR SIMILAR APPROVED WATER RESISTANT GRADED LININGS.

METAL CEILING BATTENS AT MAX, 600mm CENTRES TO BE USED THROUGHOUT.

SOFFIT LININGS

SOFFITS ARE TO BE BATTENED WITH 50 x 38mm TIMBER & SHEETED WITH 'HARDITEX' 4.5mm F.C. SHEETING,

ROOFING

CONCRETE ROOF TILES FIXED TO BATTENS IN ACCORDANCE WITH MANUFACTURERS SPECIFICATION FOR N3 ARFA

RAINWATER GUTTERS

GUTTERS FIXED TO METAL FASCIA GUTTER TO FALL TO 90mm DOWNPIPES FIXED TO WALL.

FASCIA & GUTTER SHALL BE COLORBOND AS PER CONTRACT.

DOWNPIPES TO BE ROUND 90mm PVC

THE CONTRACTOR IS RESPONSIBLE TO ENSURE COMPLIENCE WITH AS.3500, AS.2870 AND BCA

HOT WATER SERVICE

COLD WATER SERVICE LEADING TO HWS TO BE RO.3 LAGGED FOR FIRST 500mm OUT FROM HWS.

HOT WATER SERVICE LEADING FROM HWS TO ALL FIXTURES TO BE RO.3 LAGGED FOR ALL EXPOSED PIPEWORK ADJACENT TO HWS & ALL PIPEWORK IN ROOF VOID EXCEPT FOR ROOFS WITH INSULATION BLACKET/BATTS UNDER ROOFING MATERIAL.

TERMITE CONTROL

TERMITE CONTROL TO BE IN ACCORDANCE WITH AS.3660.1-2000 & BCA HOUSING PROVISIONS PART 3.1.3-TERMITE RISK MANAGEMENT.

TERMITE PROTECTION TO BE PROVIDED AS SPECIFIED. PERIMETER BARRIER AND COLLARS TO ALL SLAB PENETRATIONS.

TERMITE SYSTEM TO BE INSPECTED AND MAINTAINED AS ADVISED BY INSTALLERS, MANUFACTURER OR EVERY 12 MONTHS WHICHEVER IS THE LESSER. INSPECTIONS TO BE CARRIED OUT BY COMPETENT PERSONS.

TWO DURABLE NOTICES ARE TO BE FIXED BY BUILDER IN A PROMINENT PLACE, (EG METER BOX AND KITCHEN CUPBOARD). NOTICE IS TO SHOW METHOD OF PROTECTION, DATE OF INSTALLATION AND MANUFACTURERS RECOMMENDATION FOR FUTURE INSPECTIONS.

BUILDER TO DISCUSS AND ADVISE OWNER/CLIENT ON METHOD OF TERMITE CONTROL TO ENSURE UNDERSTANDING OF OWNERS OBLIGATIONS.

CONCRETE SLAB AND FOUNDATIONS ARE TO BE DESIGNED AND CONSTRUCTED IN ACCORDANCE WITH AS.2870.

ROOF FRAMEWORK

PREFABRICATED TRUSSES AT ROOF PITCH SPECIFIED ON PLAN AT 600mm CENTRES.

ENTIRE ROOF TO BE TRUSS CONSTRUCTION UNLESS OTHERWISE INDICATED ON FLOOR/FRAMING PLAN.

TRUSSES TO BE ENGINEER DESIGNED AND FIXED AND BRACED AS PER THE MANUFACTURERS REQUIREMENTS.

THE TRUSS MANUFACTURER SHALL PROVIDE ALL NECESSARY DOCUMENTATION AND CERTIFICATION AS REQUIRED FOR THE CONSTRUCTION/ERECTION OF THE ROOF FRAMING AND THE APPROVAL BY COUNCIL/PRIVATE CERTIFIER.

WHERE TRUNCATED AND GIRDER TRUSSES OCCUR THE TRUSS
MANUFACTURER IS TO CHECK THE ADEQUACY OF LINTELS SUPPORTING
THEM AND THE TIE-DOWN REQUIREMENTS.

TRUSS MANUFACTURER MUST NOTIFY BUILDER OF ANY CHANGE TO LINTEL OR TIE—DOWN DESIGN AT TRUSS DESIGN STAGE.
TRUSS MANUFACTURER TO NOMINATE THE NUMBER OF STUDS REQUIRED UNDER TRUNCATED AND GIRDER TRUSSES.

BOTTOM CHORD BINDERS AS PER TRUSS MANUFACTURERS SPECIFICATION AND AT MAXIMUM 3000mm CENTRES. ROOFING MATERIAL TO BE FIXED TO MANUFACTURERS SPECIFICATIONS

FOR TERRAIN CATEGORY, PROFILE AND FINISH AS PER CONTRACT.

CLIENT

QUEENSLAND SUSTAINABLE HOUSE CODE SHOWER ROSES

SHOWER ROSES TO BE AAA RATING ASSESSED AGAINST AS/NZ 6400-2004 OR A3 STAR RATING UNDER THE WATER EFFICIENCY LABELLING SCHEME (WELS)

TOILET CISTERNS

TOILET CISTERNS TO HAVE DUAL FLUSH CAPACITY THAT DOES NOT EXCEED 4.5 LITRES ON FULL FLUSH AND 3 LITRES ON HALF FLUSH.

TO MEET 4 STAR RATING

WATER SUPPLY

WHERE MAIN WATER PRESSURE AT THE OUTLET WITHIN THE BOUNDARY EXCEEDS 500Kpa A WATER PRESSURE LIMITING DEVICE TO BE INSTALLED TO ENSURE PRESSURE REMAINS BELOW 500Kpa.

A 5000 LITRE MINIMUM RAINWATER TANK TO BE INSTALLED TO SERVICE WATER CLOSETS AND WASHING MACHINE IN ACCORDANCE WITH PART 25 QUEENSLAND DEVELOPMENT CODE AND LOCAL AUTHORITIES REQUIREMENTS.

HOT WATER

PROVIDE GAS HOT WATER SYSTEM, APPROVED ELECTRICAL HEAT PUMP SYSTEM OR SOLAR HOT WATER SYSTEM WITH A FIVE STAR ENERGY RATING.

GENERAL NOTES CONCRETE TILE ROOF


AMENDMENTS

NOTE: ENGINEERS DRAWINGS TAKE PRECEDENCE OVER ARCH. DRAWINGS

WEATHER PROTECTION TO EXTERIOR MEMBERS AS PER MANUFACTURERS SPECIFICATION

LINTELS HAVE BEEN DESIGNED USING A NOTIONAL TRUSS LAYOUT. PROVIDE FINAL TRUSS LAYOUT FOR SIZE CHECK OF LINTELS SUPPORTING GIRDER TRUSSES

A TERMITE BARRIER OR COMBINATION OF BARRIERS TO BE INSTALLED IN ACCORDANCE WITH AS 3660.1 SUBJECT TO CLAUSE 3.1.3.0(a) OR 3.1.3.3 FOR CONCRETE SLABS ON GROUND OR 3.1.3.4, FOR SUSPENDED FLOORS,

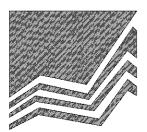

MANCORP QUALITY HOMES


PO Box 1305 Coboolture Qld 4510 Office (07) 54952011 Fax: (07) 54952677 ACN: 065 955 179

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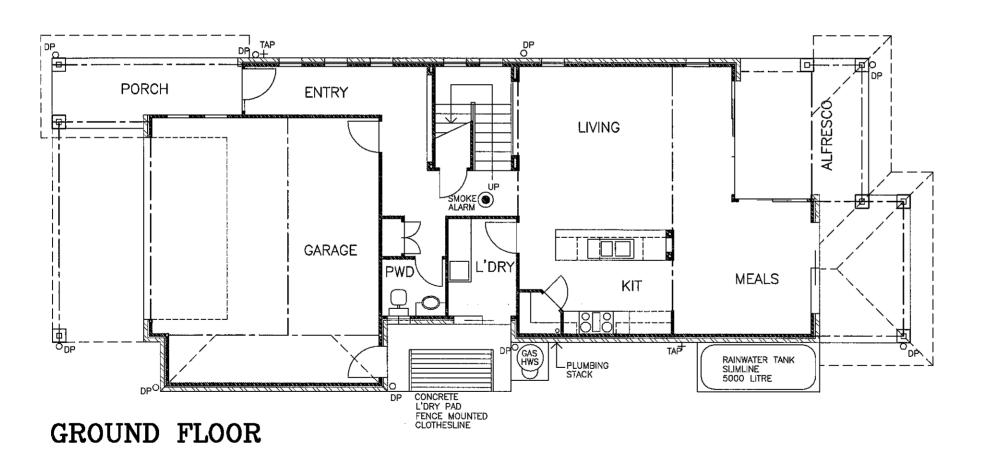
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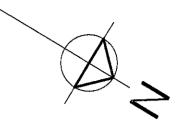
 * ALL CONSTRUCTION TO BE IN ACCORDANCE
 WITH BUILDING CODE OF AUSTRALIA AND
 AS. 1684.2 1999 TIMBER FRAMING MANUAL.
- * WINDOW CODES DENOTE HEIGHT \times WIDTH e.g. 1218 1200 HIGH \times 1800 WIDE.
- * DIMENSIONS TO BE VERIFIED BY CONTRACTORS PRIOR TO PREPARATION OF SHOP DRAWINGS OR MANUFACTURING, DIMENSIONS TAKE PREFERENCE OVER SCALE.

ISSUE	DATE	DESCRIPTION	MANCORP QUALITY HOMES	DRAWN: A.WATTS	CHECKED:
A	23/04/10	WORKING DRAWING	PROPOSED RESIDENCE	DATE: 23/04/10	SCALE: AS SHOWN
			LOCATION	JOB NO.	SHEET No.
			LOT 26 AUGUSTA PARADE, NORTH LAKES		11 OF 11



UPPER FLOOR

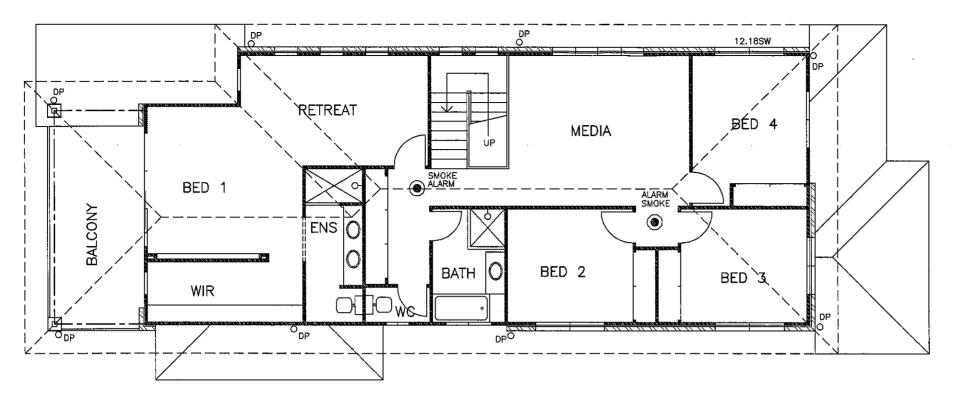



ELECTRICAL LEGEND

LIGHT POINT

FLUORESCENT LIGHT

SINGLE POWER OUTLET

DOUBLE POWER OUTLET

TV POINT

EXHAUST FAN

CEILING FAN

TELEPHONE OUTLET

WALL MOUNTED LIGHT POINT

DOWN LIGHT

WATERPROOF FLOOD LIGHT


HOT WATER UNIT

METRE BOX

SMOKE ALARM

PLUMBING & **ELECTRICAL PLAN**

SCALE 1: 100

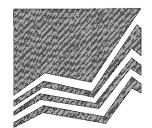

MANCORP QUALITY HOMES

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NOTE: * ALL CONSTRUCTION TO BE IN ACCORDANCE WITH BUILDING CODE OF AUSTRALIA AND AS. 1684.2 - 1999 TIMBER FRAMING MANUAL,

* WINDOW CODES DENOTE HEIGHT x WIDTH e.g. 1218 - 1200 HIGH x 1800 WIDE.

* DIMENSIONS TO BE VERIFIED BY CONTRACTORS PRIOR TO PREPARATION OF SHOP DRAWINGS OR MANUFACTURING. DIMENSIONS TAKE PREFERENCE OVER SCALE.

AMENDMENTS			CLIENT	ODAMIN, A WATTE	OUE OUE
ISSUE	DATE	DESCRIPTION	MANCORP QUALITY HOMES	DRAWN: A.WATTS	CHECKED: 27/4/10
A	23/04/10	WORKING DRAWING	PROJECT PROPOSED RESIDENCE	DATE: 23/04/10	SCALE: AS SHOWN
			LOCATION	JOB NO.	SHEET No.
			LOT 26 AUGUSTA PARADE, NORTH LAKES		Additional 1